





Approved Construction Plan Name Date		
Planning		
Fire		
WILMINGTON		
NORTH CAROLINA Public Services Engineering Division APPROVED STORMWTER MANAGEMENT PLAN Date: Permit #	PRELIMINARY SITE PLAN CAPEFEAR SOLAR SV WILMINGTON TOWNSHIP NEW HANOVER COUNTY	STENS NORTH CAROLINA
C GEAL	OWNER: CAPE FEAR SOLAR SYSTEMS	DESIGNED: JHF
20643 ENGINE ENGINE ENGINE ENGINE	ADDRESS: IOHN DONOGHUE 901 MARTIN ST. SUITE C-6 WILMINGTON, NC 28401 910-409-5533 john@CapeFearSolarSystems.com	DRAWN: JHF
	jonna Caperearsonarsystems.com	APPROVED: JHF DATE: 2/26/21
JANES H. RENTRESS, JR. P.E.	STROUD ENGINEERING, P.A.	SCALE: 1" = 30'
Mar 05, 2021 JANES H. RENTRESS. JR P.E. DATE	102-D CINEMA DRIVE WILMINGTON, NORTH CAROLINA 28403 (910) 815-0775 (910) 815-0593 FAX	SHEET 2 OF 10

DALE LOVITT DB5296, PG.915 LU = 551, RETAIL/AUTO ZONING = UMX

0'50'31"

++	FIRE HYDRANT
SSMH	SEWER MAN HOLE
FIP	POWER POLE
	OVERHEAD ELECTRIC
.	LIGHT POLE
	ELEVATION CONTOUR
	STORMWATER
LT 249	N83*51'46"E 10.00'
24.0FE	PROPOSED FINISH GRADE
	PROPOSED LIMITS OF DISTURBANCE
	PROPOSED SILT FENCE
FDC	PROP. FIRE DEPT. CONNECTION
LE	GEND

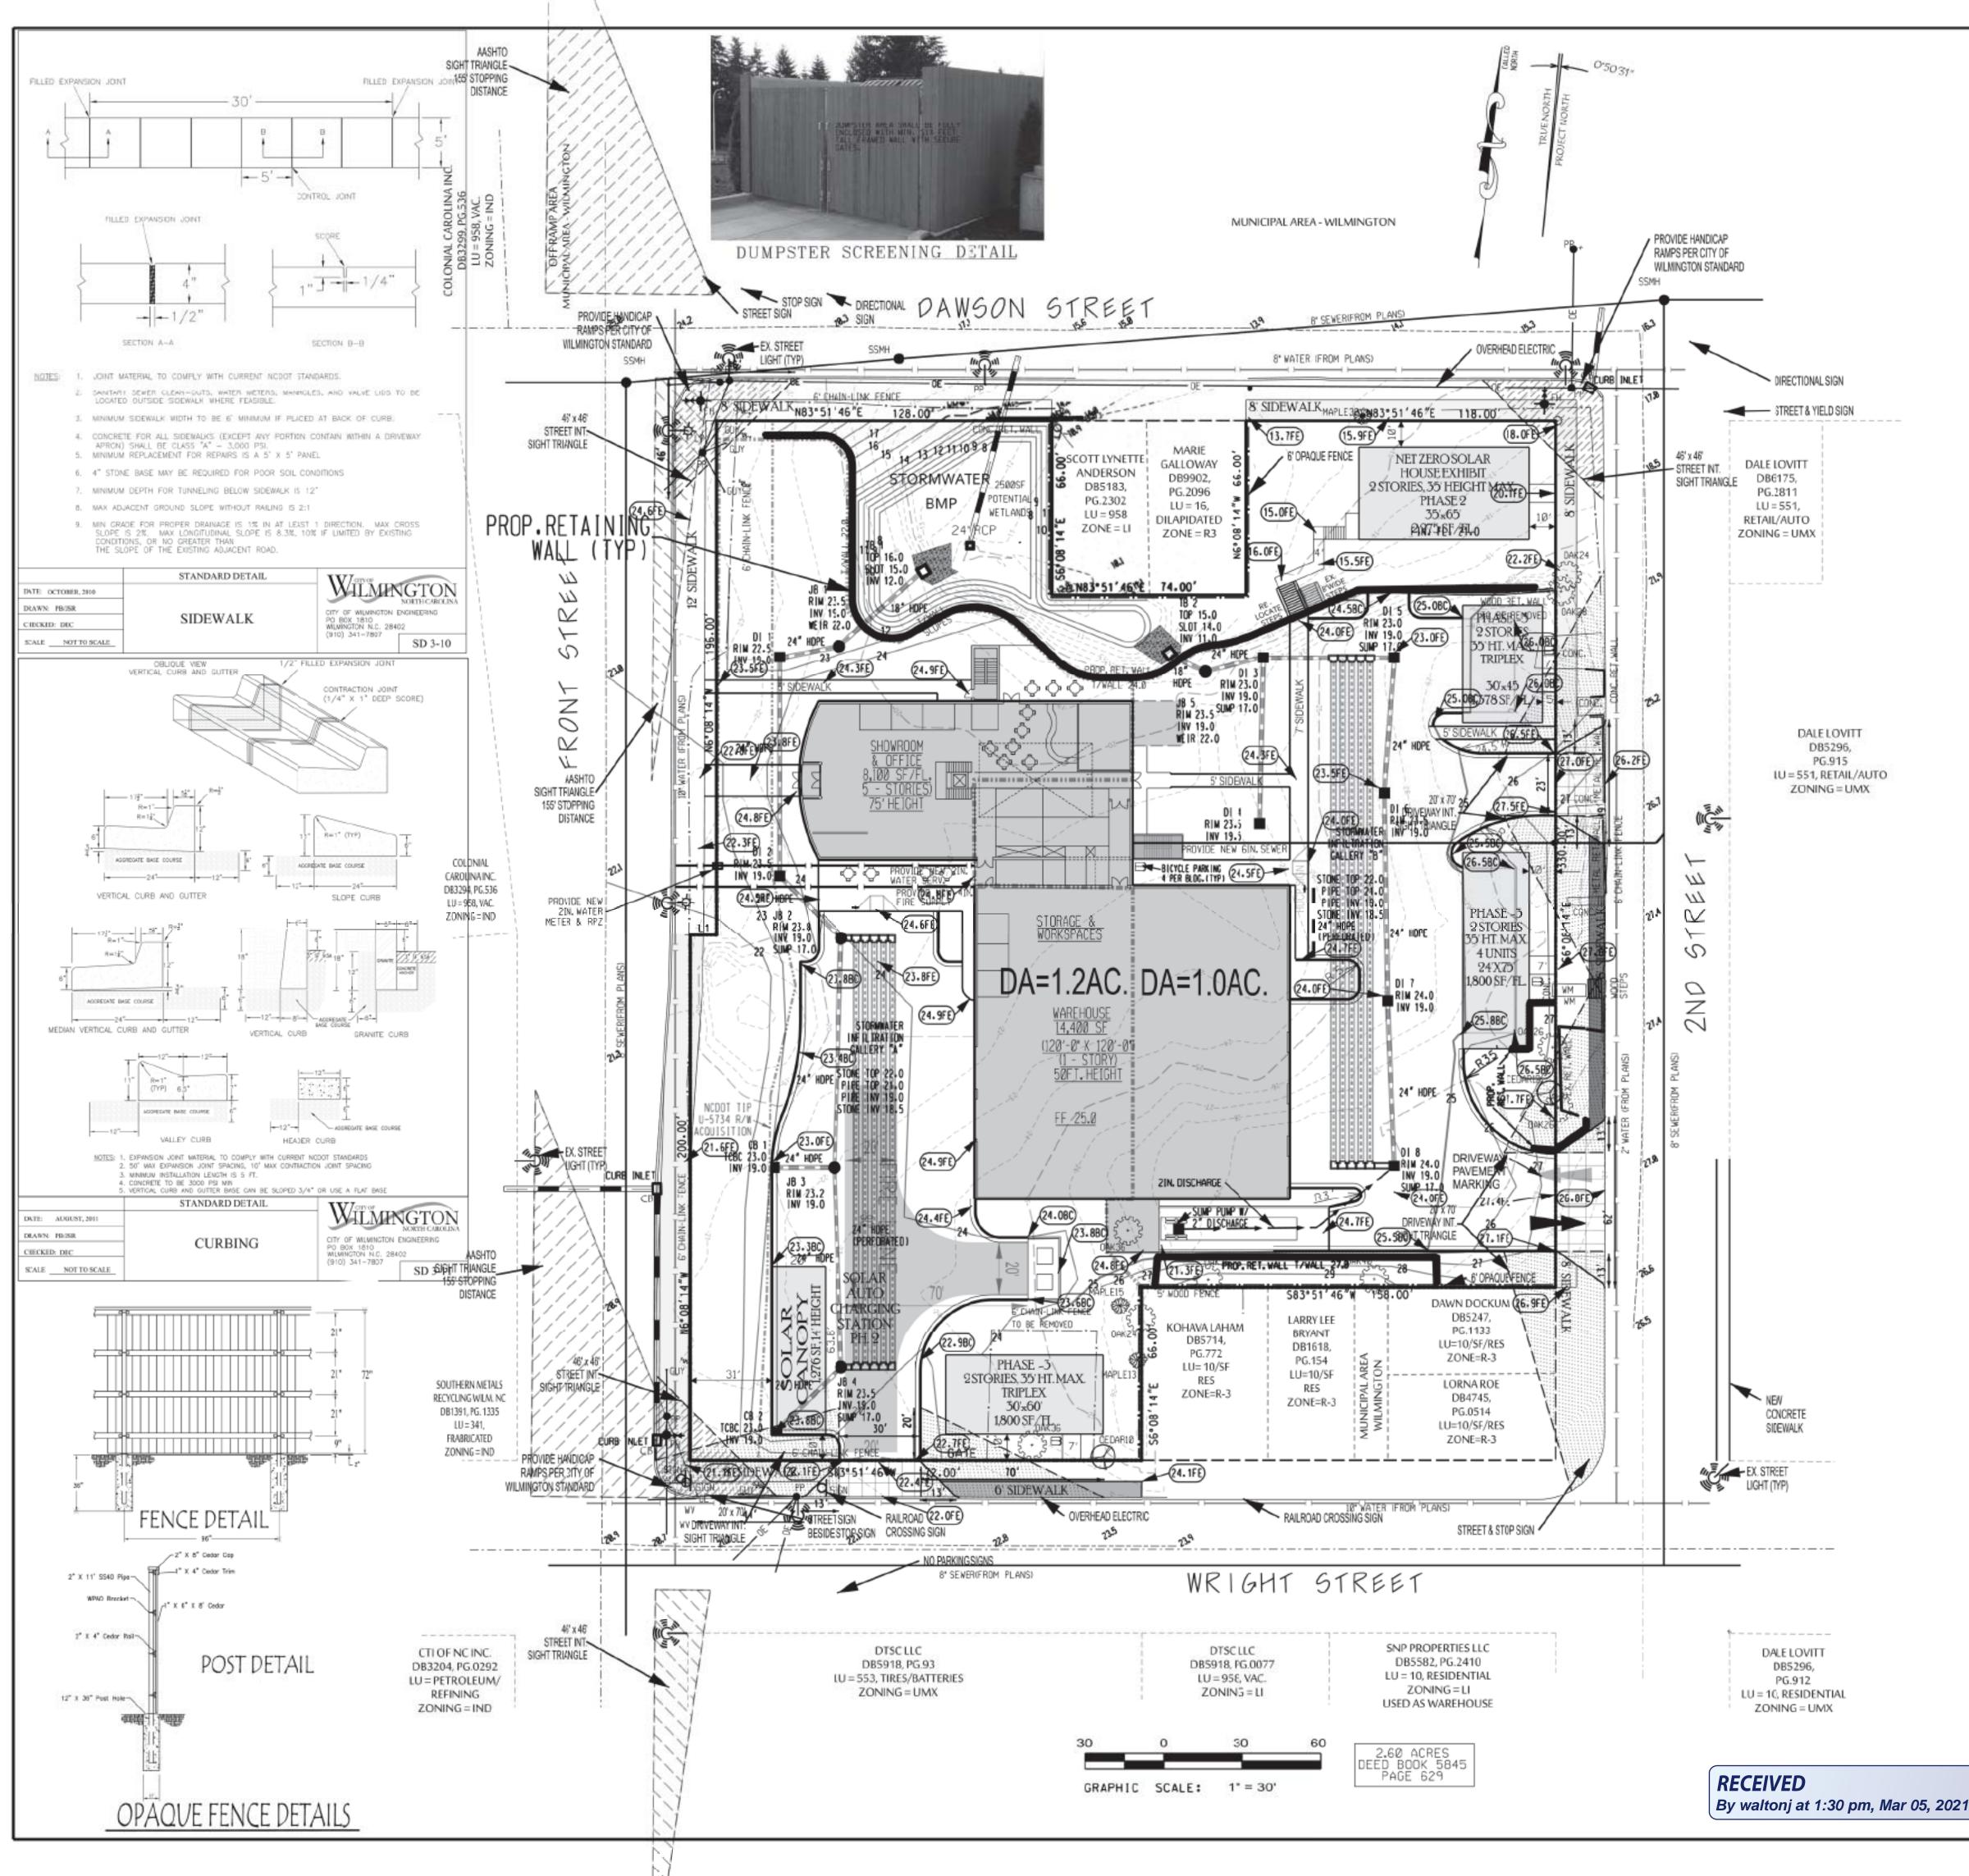

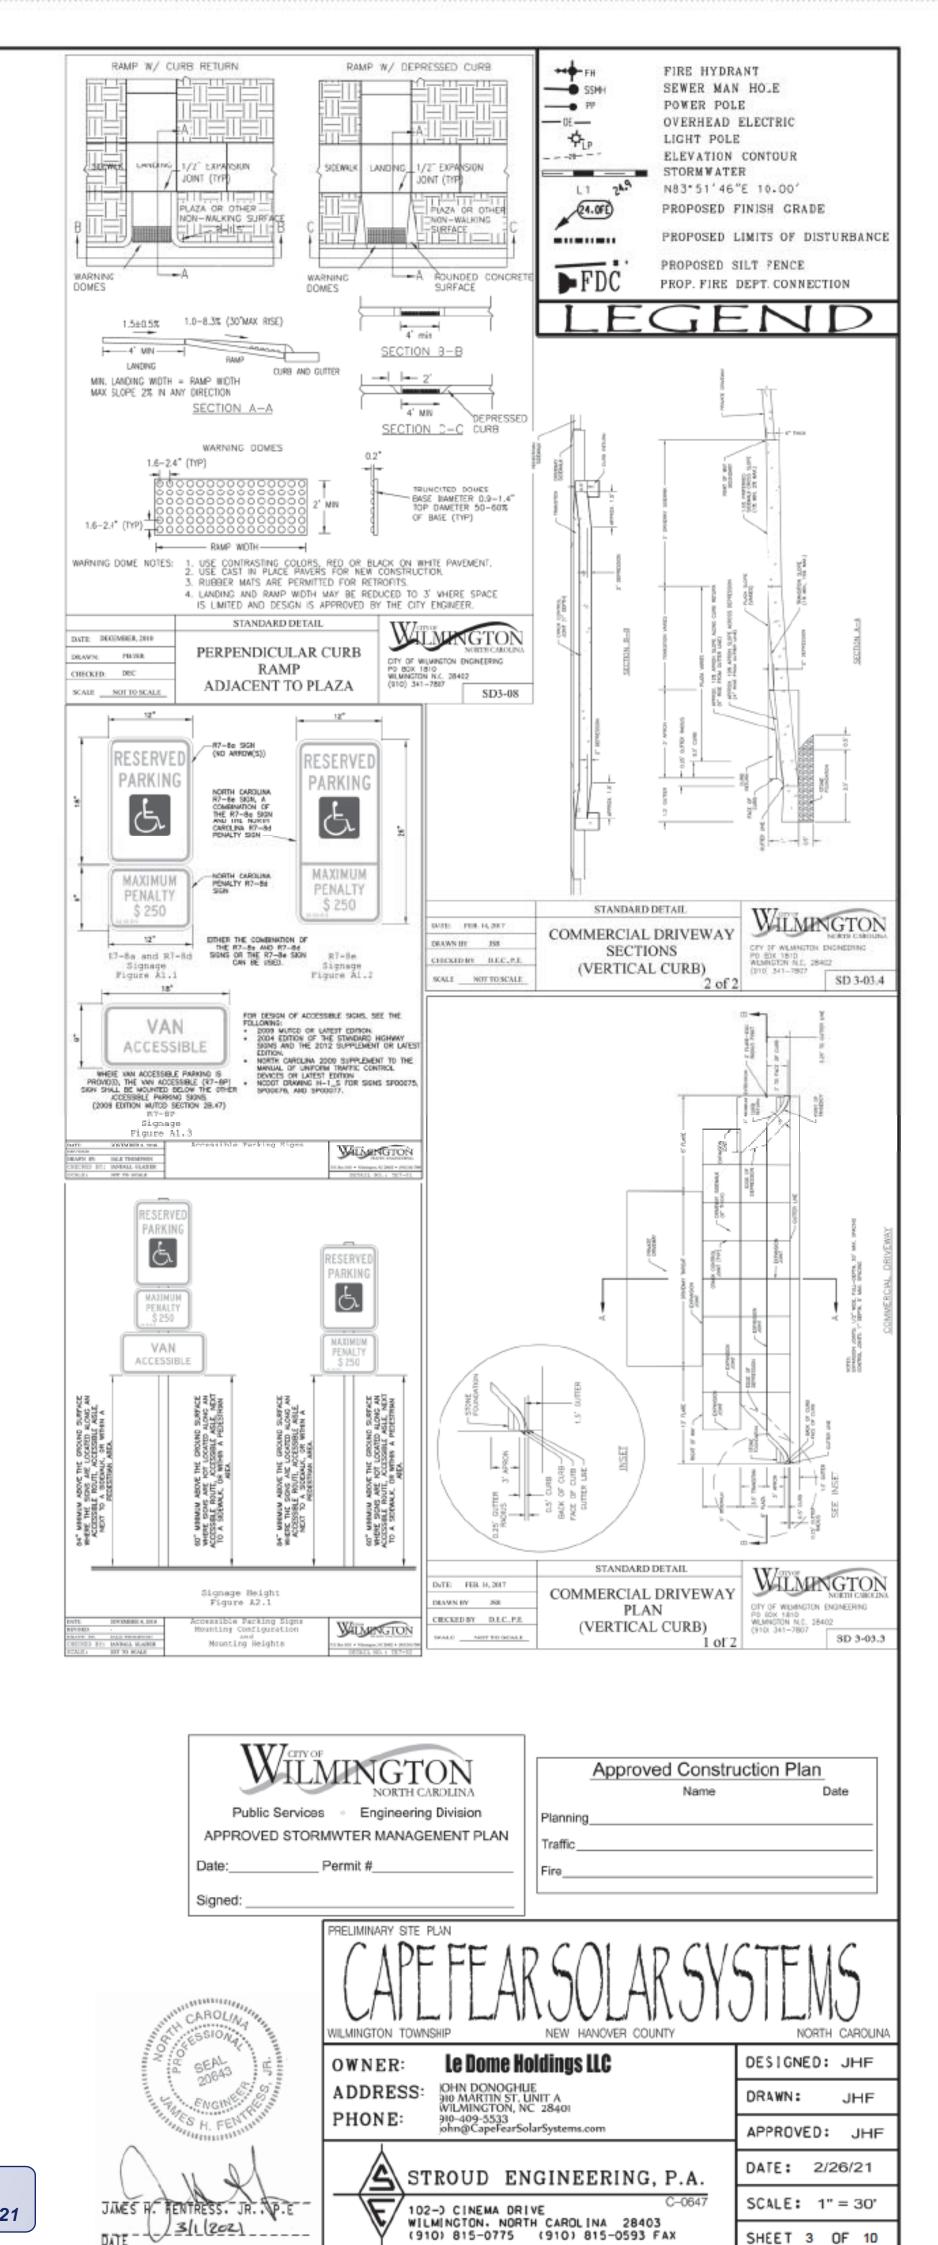

SHEET 3 OF 10

DATE - 23/1/2021

	NPDES	NOTES
SITE AREA DESCRIPTION	STABILIZATION TIMEFRAME	STABILIZATION TIMEFRAME EXCEPTIONS
PERIMETER DIKES, SWALES, AND DITCHES	7 DAYS	NONE
HIGH QUALITY WATER (HOW) ZONES	7 DAYS	NONE
SLOPES STEEPER THAN 3:1	7 DAYS	IF SLOPES ARE 10' OR LESS IN LENGTH AND FLATTER THAN 2:1 THEN 14 DAYS
SLOPES 3:1 OR FLATTER	14 DAYS	7 DAYS FOR SLOPES GREATER THAN 50' IN LENGTH.
OTHER AREAS WITH SLOPES FLATTER THAN 4:1	14 DAYS	NONE (EXCEPT FOR PER]METERS AND HOW ZONES)
BUILDING WASTES HAN 1. NO PAINT OR LIQUID WASTES IN STREA 2. DEDICATED AREAS FOR DEMOLITION, CO WASTES MUST BE LOCATED 50' FROM ST UNLESS NO REASONABLE ALTERNATIVES 3. EARTHEN-MATERIALS STOCKPILES MUST STORM DRAINS AND STREAMS UNLESS NO ALTERNATIVES AVAILABLE. 4. CONCRETE MATERIALS MUST BE CONTROL WITH SURFACE WATERS, WETLANDS, OR INSPECTIONS 1. SAME WEEKLY INSPECTION REQUIREMENT 2. SAME RAIN GAUGE AND INSPECTIONS AF 3. INSPECTIONS ARE ONLY REQUIRED DURI 4. INSPECTION REPORTS MUST BE AVAILABLE HOURS UNLESS A SITE SPECIFIC EXEMP 5. RECORDS MUST BE KEPT FOR 3 YEARS A	MS OR STORM DRAINS. INSTRUCTION. AND OTHER ORM DRAINS AND STREAMS AVAILABLE. BE LOCATED 50' FROM D REASONABLE LED TO AVOID CONTACT BUFFERS. S TER 0.5" RAINFALL EVENT. NG "NORMAL" BUSINESS HOUR LE ONSITE DURING BUSINESS TION IS APPROVED.	

EROSJON & SEDIMENT CONTROL MAINTENANCE PLAN

CERTAIN CONDITIONS.

6. ELECTRONICALLY AVAILABLE RECORDS MAY BE SUBSTITUTED UNDER

- 1. ALL EROSION AND SEDIMENTATION CONTROL MEASURES WILL BE CHECKED FOR STABILITY AND OPERATION FOLLOWING EVERY RUNOFF-PRODUCING RAINFALL BUT IN NO CASE LESS THAN ONCE EVERY WEEK AND WITHIN 24 HOURS OF EVERY HALF INCH RAINFALL
- 2. ALL POINTS OF EGRESS WILL HAVE CONSTRUCTIONS ENTRANCES THAT WILL BE PERIODICALLY TOP-DRESSED WITH AN ADDITIONAL 2" OF #4 STONE TO MAINTAIN PROPER DEPTH. THEY WILL BE MAINTAINED IN A CONDITION TO PREVENT MUD OR SEDIMENT FROM LEAVING THE SITE. JMMEDIATELY REMOVE OBJECTIONABLE MATERIAL SPILLED, WASHED, OR TRACKED ONTO THE CONSTRUCTION ENTRANCE OR ROADWAYS.
- 3. SEDIMENT WILL BE REMOVED FROM HARDWARE CLOTH AND GRAVEL INLET PROTECTION, BLOCK AND GRAVEL INLET PROTECTION, ROCK DOUGHNUT INLET PROTECTION, ROCK PIPE INLET PROTECTION, AND GUTTERBUDDY INLET PROTECTOIN WHEN THE DESIGNED STORAGE CAPACITY HAS BEEN HALF FILLED WITH SEDIMENT. ROCK WILL BE CLEANED OR REPLACED WHEN THE SEDIMENT POOL NO LONGER DRAINS AS DESIGNED. DEBRIS WILL BE REMOVED FROM THE ROCK AND HARWARE CLOTH TO ALLOW PROPER DRA]NAGE. S[LT SACKS W]LL BE EMPT]ED ONCE A WEEK AND AFTER EVERY RAIN EVENT. SEDIMENT WILL BE REMOVED FROM AROUND BEAVER DAMS, DANDY SACKS/SOCKS, AND GUTTERBUDDIES ONCE A WEEK AND AFTER EVERY RAIN EVENT. NOTE THAT THE GUTTERBUDDY IS REUSABLE SHOULD BE STORED OUT OF DIRECT SUNLIGHT BETWEEN JOBS.
- DIVERSION DITCHES WILL BE CLEANED OUT IMMEDIATLEY TO REMOVE SEDIMENT OR OBSTRUCTIONS FROM THE FLOW AREA. THE DIVERSION RIDGES WILL ALSO BE REPAIRED. SWALES MUST BE RESTABLIZED WITHIN 21 CALENDAR DAYS OF CEASE OF ANY PHASE OF PHASE OF ACTIVITY ASSOCIATED WITH A SWALE.
- 5. SEDIMENT WILL BE REMOVED FROM BEHIND THE SEDIMENT FENCE WHEN IT BECOMES HALF FILLED. THE SEDIMENT FENCE WILL BE REPAIRED AS NECESSARY TO MAINTAIN A BARRIER. STAKES MUST BE STEEL. STAKE SPACING WILL BE 6 FEET (MAX) WITH THE USE OF EXTRA STRENGHT FABRIC WITHOUT WIRE BACKING. STAKE SPACING WILL BE 8 FEET (MAX) WHEN STANDARD STRENGTH FABR]C AND W]RE BACKING ARE USED. IF ROCK FILTERS ARE USED AT LOW POINTS IN THE SEDIMENT FENCE, THE ROCK WILL BE REPAIRED OR REPLACED IF IT BECOMES HALF FULL OF SEDIMENT. NO LONGER DRAINS AS DESIGNED. OR IS DAMGED.
- 6. SEDIMENT WILL BE REMOVED FROM THE SEDIMENT TRAPS AND BASINS WHEN THE DESIGNED STORAGE CAPACITY HAS BEEN HALF FILLED WITH SEDIMENT. ROCK WILL BE CLEANED OR REPLACED WHEN THE SEDIMENT POOL NO LONGER DRAINS OR WHEN THE ROCK [S DISLODGED. BAFFLES WILL BE REPAIRED OR REPLACED IF THEY COLLAPSE. TEAR. DECOMPOSE. OR BECOME [NEFFECT]VE. THEY WILL BE REPLACED PROMPTLY. SEDIMENT WILL BE REMOVED WHEN DEPOSITS REACH HALF THE HEIGHT OF THE FIRST BAFFLE, IN SKIMMER BASINS, FLOATING SKIMMERS WILL BE INSPECTED WEEKLY AND WILL BE KEPT CLEAN.
- ALL SEEDED AREAS WILL BE FERTILIZED. RESEEDED AS NECESSARY. AND MULCHED ACCORDING TO SPECIFICATIONS IN THE VEGETATIVE PLAN TO MAINTAIN A VIGOROUS, DENSE VEGETATIVE COVER, ALL SLOPES WILL BE SLABILIZED WITHIN 21 CALENDAR DAYS, ALL OTHER AREAS WILL BE STABILIZED WITHIN 15 WORKING DAYS.
- FLOCCULANTS WILL BE USED TO ADDRESS TURB[D]TY [SSUES. THE PUMPS, TANKS, HOSES AND INJECTION SYSTEMS WILL BE CHECKED FOR PROBLEMS OR TURBID DISCHARGES DAILY.

NOTE:

WETLANDS IN DISTURBED PORTIONS OF SITE SHALL BE PERMITTED BY USACE AND NCDEQ AS REQUIRED.

CONSTRUCTION SEQUENCE

- INSTALL [NLET PROTECT]ON, S]LT FENCE, AND STONE CONSTRUCTION ENTRANCES.
- CLEAR & GRADE
- 3. INSTALL UNDERGROUND UT[L]TIES INSTALL PAVEMENT
- PROVIDE 100% VEGETATIVE COVER OF ALL DISTURBED SOILS.
- CLEAN SEDIMENT FROM PJPES AFTER STABILJZATION.

COASTAL PLAIN SITE STABILIZATION SCHEDULE

- Fertilize and lime per recommendations of soil tests or apply 2,000 lb/acre ground agricultural limestone and 750 lb/acre 10-10-10 fertilizer. [ncorporate lime/fertilizer 4-6 inches.
- Roughen steep slopes by tracked machinary.
- Select species based on season, Refer to tables,
- Broadcast seeds evenly and cover by raking or dragging a chain. Firm soil by rolling.
- Apply straw mulch at a rate 1-2 tons per acre. Anchor straw by tacking with asphalt, netting, or a mulch anchoring tool. A disk with blades set nearly straight can be
- used as a mulch anchoring tool. Refertilize if growth is not fully adequate. Reseed, refertilize and mulch immediately following erosion or other daMGe.

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	PERMANENT SEEDING TABLE 1			
Seeding [)ates	Recommended Planting	Rate (Ib/ac)	
Feb. 15 - Sep. 1 -	Apr 1 Nov 1	Tall Fescue Mixture	see table 2	
Apr. 1 -	Aug. 1	Hybrid Bermudagrass	see table 2	
Apr. 1 -	Jul. 15	Common Bermudagrass	see †able 2	
Mar. 1 -	Jul. 1	Centipedegrass	see table 2	

PERMANENT SEEDING TABLE 2d-LOW MAINTENANCE MIXTURES Cite Decomination Decom monded Digeting | Deta (ib)

Site Description	Recommended Planting	Rate (Ib/oc)
	Tall Fescue Mixture Pensacola Bahiagrass Kobe Lespedeza	80 50 40
Dry to well drained soils	Pensacola Bahiagrass Common Bermudagrass Kobe Lespedeza German Millet	50 30 10 10
Swales	Common Bermudagrass	40-80

PERMANENT SEEDING TABLE 26-HIGH MAINTENANCE MIXTURES Site Description Recommended Planting Rate (Ub/oc)

SITE Description	Recommended Planting	Rate (ID/ac)
Well to poorly drained soils	Tall Fescue Mixture Rye Grain	200 25
Dry to well drained soils	Hybrid Bermudagrass	50
Well drained sandy loam to sand, lawns,	Centipedegrass	10-20

Notes:

For seeding outside of recommended dates and/or for temporary stabilization, refer to temporary seeding table.


For highly erosive areas or as directed by an engineer, sod shall be provided.

TEMPORARY SEEDING TABLE


	Recommended Planting	
Dec. 1 - Apr. 15	Kobe Lespedeza with Rye Grain	50 120
Apr. 15 – Aug. 15	German Millet	40
Aug. 15 - Dec. 1	Rye Grain	120

SOD INSTALLATION


- Fertilize and lime per recommendations of soil tests or apply 100 lb/1,000 sf ground agricultural limestone and 25 lb/1,000 sf fertilizer. (n the foll, use 10-10-10. (n the spring, use 5-10-10.
- Incorporate lime/fertilizer 4-6 inches.
- Rake or harrow to achieve a smooth final grade. Roll to achieve a smooth, firm surface on which
- to lay the sod.
- 5. Lightly rake and irrigate top layer of soil just prior to installation.
- 6. Lay sod in a staggered, brick-like pattern with the longest dimension perpendicular to the slope.
- Avoid gaps, Use a knife to fit irregular shapes. Roll sod lightly after installation to ensure
- good sod to soil contact.
- Irrigate initially to wet soil to a depth of 4". Keep soil moist for 2-3 weeks thereafter or until sod has taken root.

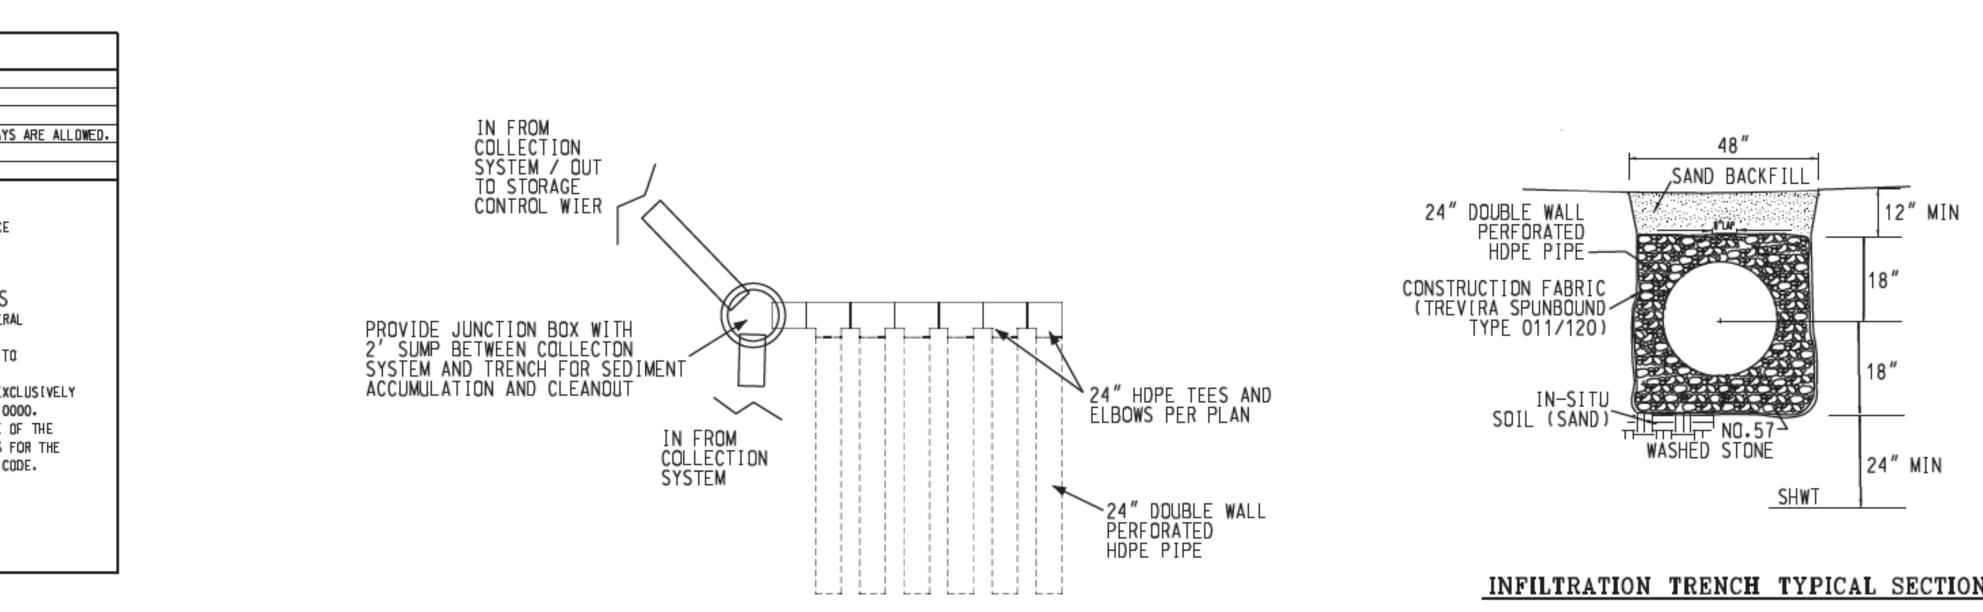

INFILTRATION TRENCH TYPICAL LAYOUT

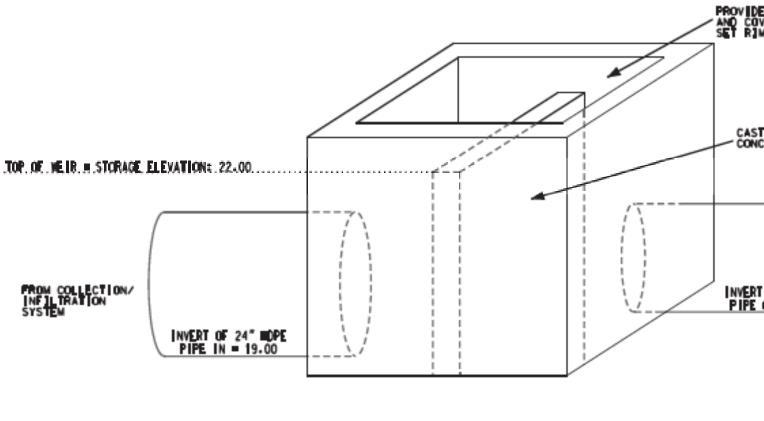



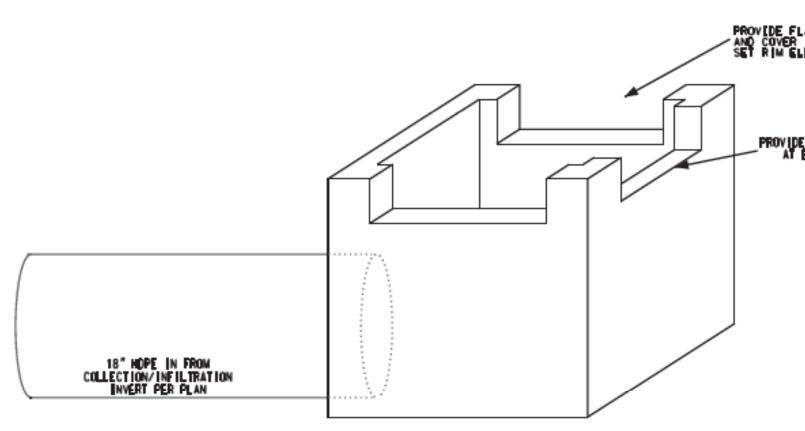

THROAT BOXENERGY DISSIPATOR DET

N.T.S.

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By waltonj at 1:30 pn


INFILTRATION TRENCH TYPICAL SECTION

PROVIDE FLAT TOP WITH RING AND COVER (NOT SHOWN FOR CLARITY) SET RIM ELEVATION PER PLAN

CAST IN PLACE

TO THROAT BOX ENERGY DISSIPATOR INVERT OF 18" IDPE PIPE OUT = 19.00

			Approved Construct	ion Plan
			Name	Date
			Planning	
AT TOP WITH RING (Not Shown For Clarity) Evation PER Plan			Traffic	
Evellow PER PEed			Fire	
(3) 3.0 X 0.5' SLOTS LEVATION PER PLAN	c	or each open utility cut of Ity streets, a \$325 permit hall be required from the City prior to occupancy nd/or project acceptance.	Public Services • Enginee APPROVED STORMWTER MAN/ Date: Permit # Signed:	-
		CITY OF WILMINGTON DRAINAGE P	UTH SECOND STREET WILMINGTON, NO	STEMS
A TT	CAROLINI	DEVELOPER: CAPEF	EAR SOLAR SYSTEMS	DESIGNED: DLM
AIL	SEAL SEAL	ADDRESS: JOHN DONOG 901 MARTINS	GHUE T. SUITE C-6 I, NC 28401 arSolarSystems.com	DRAWN: DLM
	E · 35677 · =	PHONE: 910-409-5533 john@CapeFe	arSolarSystems.com	APPROVED: DLM
	DEVGINE C. BUILT	STROUD I	ENGINEERING, P.A.	DATE: 3/4/2020
n, Mar 05, 2021		102-D CINEMA	C-0647	SCALE: AS NOTED
,,	DAVID L. MENTUS. P.E 9/23/2020	(910) 815-0775	ORIVE ORTH CAROLINA 28403 5 (910) 815–0593 FAX	SHEET 4 OF 10

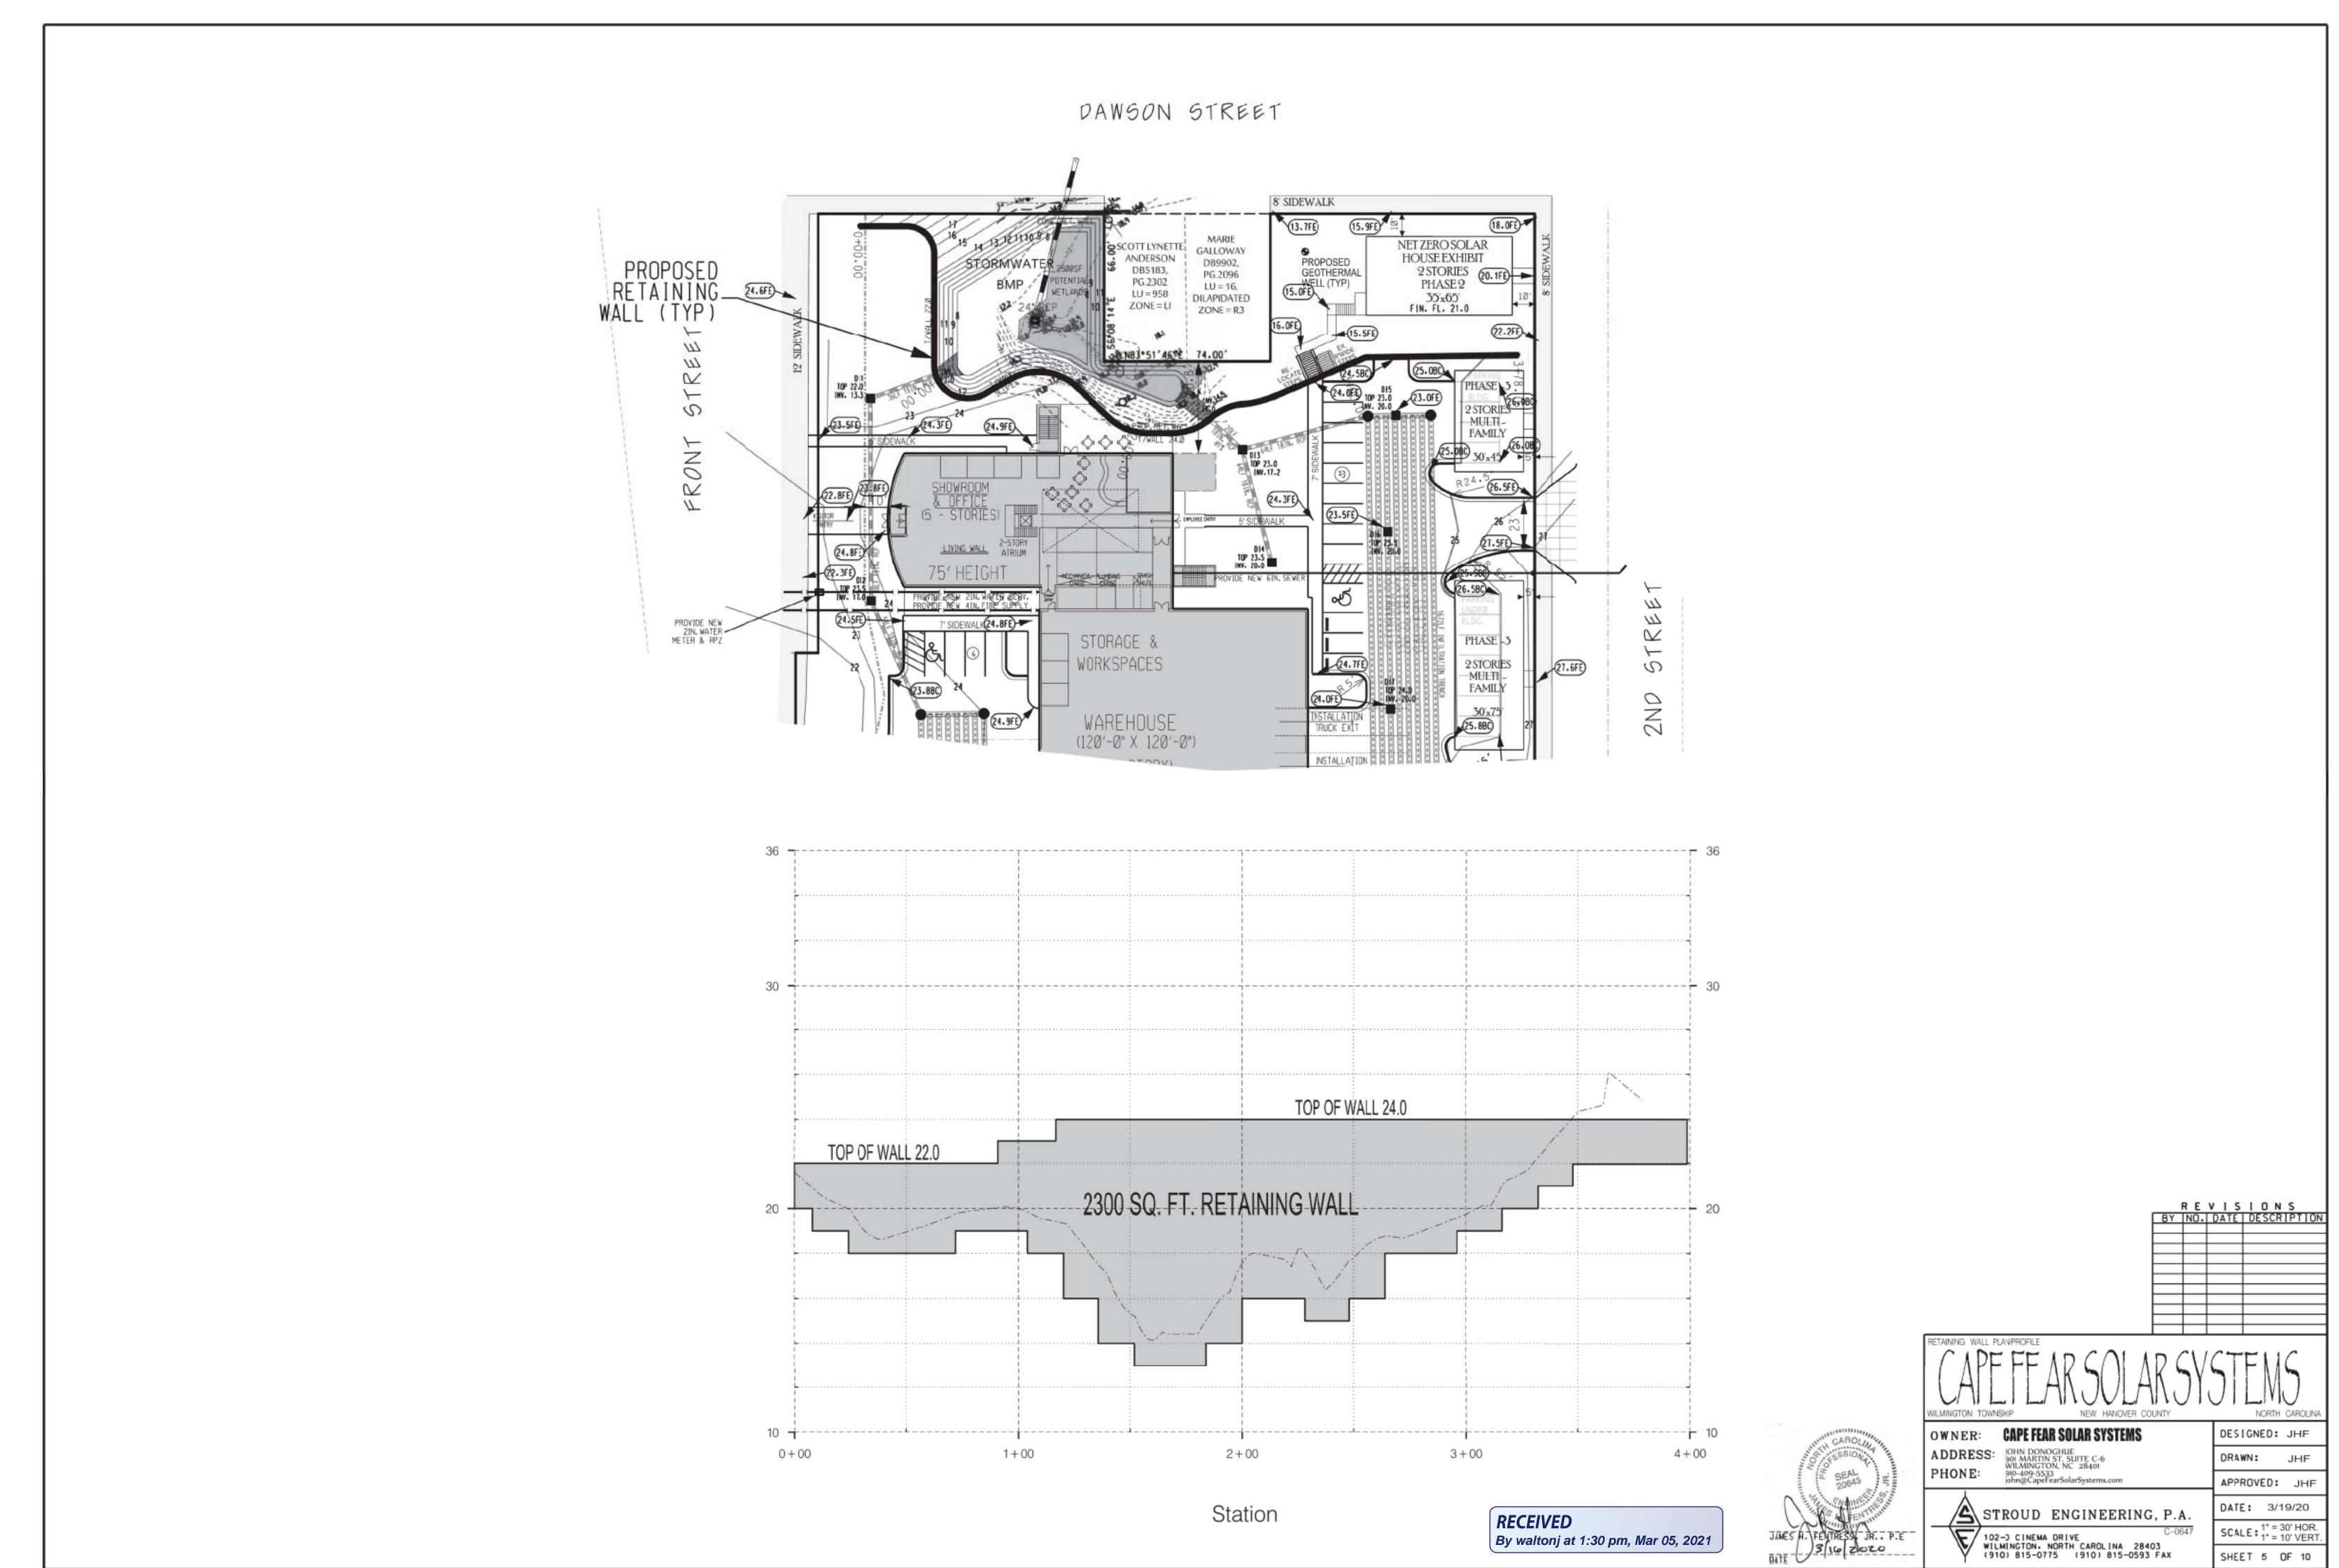

DAWSON STREET

7 7 2


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2

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7

-2



WRIGHT STREET

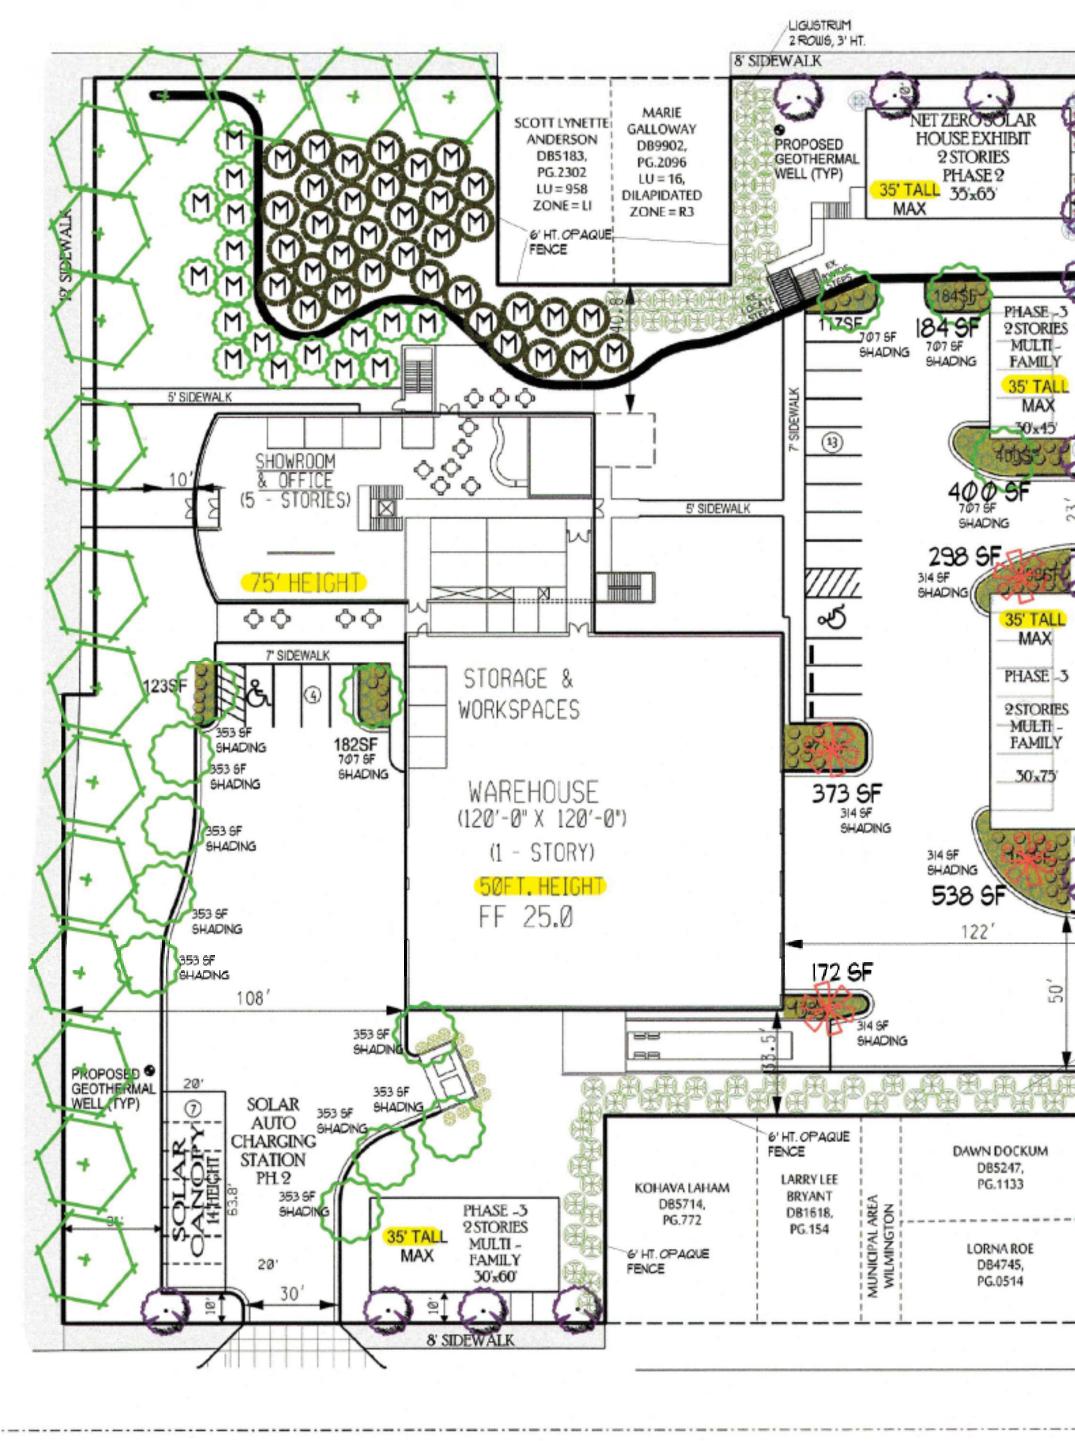3Ø Scale: Revision #: Lanc 10 20 Cape Fear Solar Date: 11/23/2020 1" = 30'

THACT AREA 2.6. AC X 5-20 TREES 2 CALPER BOD, 47 PROVD. ADDRESS 001 S. FRONT STREET 20185 2019 S. FRONT STREET 2011DINGS PROVIDED BUILDINGS PROVIDED DEED BOOK/PACE - 5445/623 BUILDING SETBACKS BUILDING SETBACKS BUILDING METGAT- 10' MAX SIDE 5' BUILDING HETGAT- 5' - SUP REQUIRED PARKING & DRIVES 33,200 ST X20-6524 OF INTERCOR GHADING REQOD RECIEVING STREAM- CAPE FEAR RIVER CLASSIFICATION 5C RECUVING STREAM- CAPE FEAR RIVER CLASSIFICATION 5C PROP. PARKING SPACES 77*56'47.9"W SITTE DATA	1 2 34 50 F03337T N115	ANDSCAPE NOTES: PRIOR TO ANY CLEAF TREE PROTECTION F TREES OR GROVES O MATERIALS OR VEHIC FENCING. THE AREAS WITHIN T MAINTAINED FREE OI A RAIN/FREEZE SENS USING THE CREATIVE SHALL BE PLANTED A ALL PLANT BEDS ARE ALL PLANT BEDS ARE A	ENCING WILL BE INST OF TREES. NO CONST CLES ARE PERMITTED HE TRIANGULAR SIGH F ALL OBSTRUCTIONS OR SHALL BE USED IF S CALLED OUT. TO RECEIVE 3-4" OF BE COMPLETE BEFC COMPLETE BEFC COMPLETE COMPLETE BEFC COMPLETE BEFC C	ALLED A RUCTION WITHIN T DISTAU BETWEE THERE CODE, 50 PINESTR RE ISSU
LEGEND				
	2TY		QTY REQ'D	
	20		38	
BOXWOOD, WINTERGREEN	38		50	
	71		7	:
	6		Ø	N
	36		Ø	<u> </u>
YEW, UPRIGHT JAPANESE	11		1	
TREE, DECIDUOUS		MITIGATION		
GOLDEN RAINTREE	14	Ø	14	
	16	Ø	16	
MITIGATION SEAGLESTON HOLLY, TREE FORM	4	Ō	4	
	35	35	Ø	
TRIDENT MAPLE	3Ø	17	13	
APPRO VED STOR MWATER MANAGE MENT PLAN Date: Permit # Signed:			Date	
Signed: Fire			ndsca	oe



Freeman Landscape, Inc.

SHEET 6 OF 10

Design by: Jim Freeman - NCLC# 0071

JIM@FREEMANLANDSCAPE.COM 910-796-1166

RECEIVED

By waltonj at 1:30 pm, Mar 05, 2021



12"	3 GAL.
12"	7 GAL.
36"	7 GAL.
NA	3 GAL.
NA	3 GAL.
3'	7 GAL.
8'	2" CAL.
8'	2" CAL.
8'	2" CAL
8'	2" CAL.
8'	2" CAL.

CANOPY CANOPY **UNDERSTORY** CANOPY CANOPY


HT	SIZE	/CALIPER
12" 12"		3 GAL. 7 GAL.
36"		7 GAL.



CTION ACTIVITY, AROUND PROTECTED N WORKERS, TOOLS, THE TREE PROTECTION

ANCE SHALL BE EEN 30" AND 10'. IS AN IRRIGATION SENSOR. 0% OF THE STREETYARD

RAW OR MULCH. UANCE OF A CO.

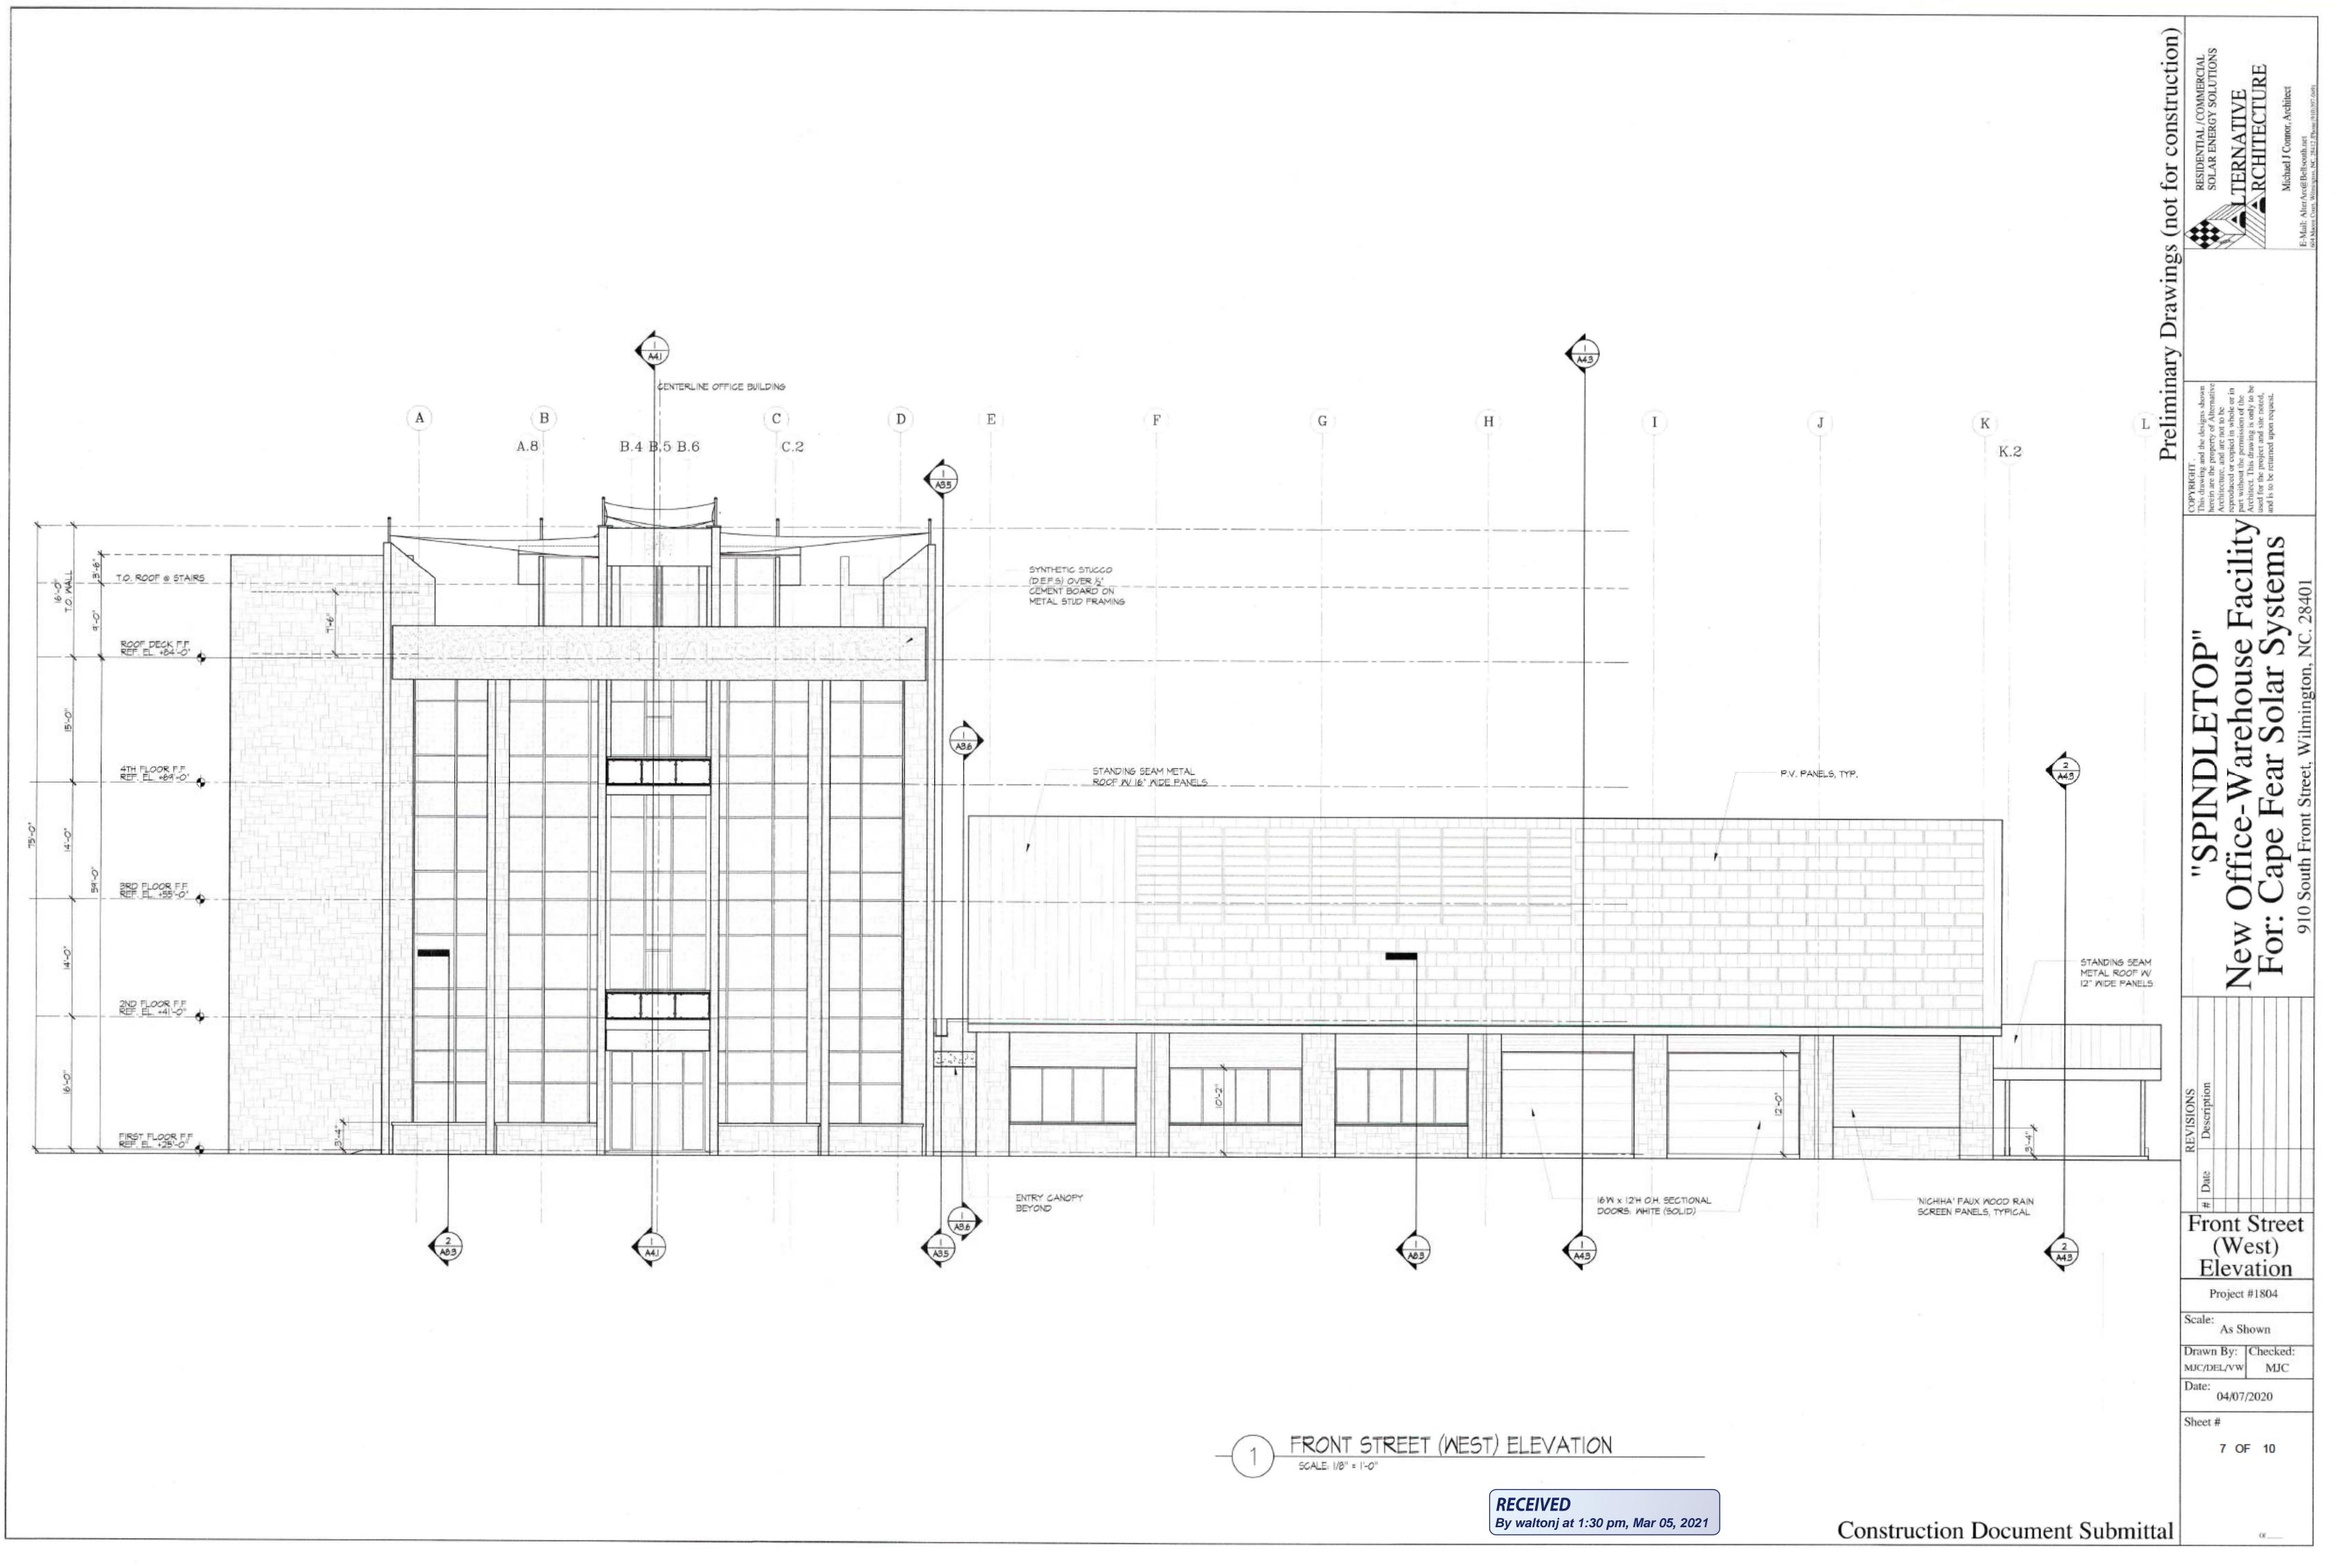

(A42) p2 3 pl COLORED CANVAS CANOPY (SEE ROOF PLAN) - × - -NN T.O. PARAPET OR RAILING (T.B.D.) SYNTHETIC STUCCO (D.E.F.S) OVER ½" CEMENT BOARD ON METAL STUD FRAMING ROOF DECK FF Y REF. EL. +84'-0" ····· 17 the state pass and tions and have seen and seen one HORIZONTAL SOLAR 101 SHADING DEVICE, TYP. 4TH FLOOR F.F. REF. EL. +69'-0'-. . -CP1 OPAQUE GLAZING AT CURTAIN WALL SPANDREL PANELS, TYP. in the second BRD FLOOR F.F. REF. EL. +55-0 2ND FLOOR F.F. REF. EL. +41-0 -114 ____ _____ 1 17 5-4-MAX, TYP DOUBLE-INS. CLEAR GLAZING AT CURTAIN WALL, TYPICAL 40 4 FIRST FLOOR F.F. REF. EL. +25'-0 111/00

STONE VENEER OVER CMU WALL @ PLANTER

A42

